

**LUMINAIRE SCHEDULE**

CALLOUT	SYMBOL	LAMP	DESCRIPTION	BALLAST	MOUNTING	MODEL	INPUT WATTS	VOLTS	NOTES
SI 250		(1) 250W	250W HIGH PRESSURE SODIUM WITH INTERNAL BALLAST, CUTOFF	MAGNETIC	POLE	AMERICAN ELECTRIC 125 25S CA M7 R2 FG	250	277V 1P 2W	TYPE II SHORT CUTOFF MULTI-TAP BALLAST



**NOTES:**

- REFER TO SEATTLE CITY LIGHT MATERIAL STANDARD 5705.2 FOR POLE ARM AND MOUNTING BRACKET REQUIREMENTS.
- REFER TO SEATTLE CITY LIGHT MATERIAL STANDARD 5723.1 FOR LUMINAIRE REQUIREMENTS.
- REFER TO SEATTLE CITY LIGHT MATERIAL STANDARD 5739.8 FOR POLE REQUIREMENTS.
- COORDINATE WITH STEPHANIE FRANKLIN (SCL) (206) 684-0604 BEFORE REMOVAL OF ANY EX. STREET LIGHTING.
- REFER TO SEATTLE STANDARD PLAN #543 FOR FOUNDATION.

**LEGEND**

	=EXISTING FLOW LINE
	=FINISHED TOP OF CURB
	=BACK OF WALK
	INLET TYPE 250
	CATCH BASIN CB TYPE 242
	CATCH BASIN CB TYPE 242B
	TREE PIT
	ADA TACTILE PANELS
	TRUNCATED DOMES
	TREE WELL AND GRATE
	STREET LIGHT (COBRA HEAD)
	PROPERTY BOUNDARY
	PAVEMENT PATCH PER C.O.S. STD PLAN #404A
	EXISTING ASPHALT STREET
	PROPOSED CONCRETE SIDEWALK
	NEW PAVEMENT
	SAWCUT LINE
	4" DOMESTIC WATER METER

SCALE: 1" = 20'

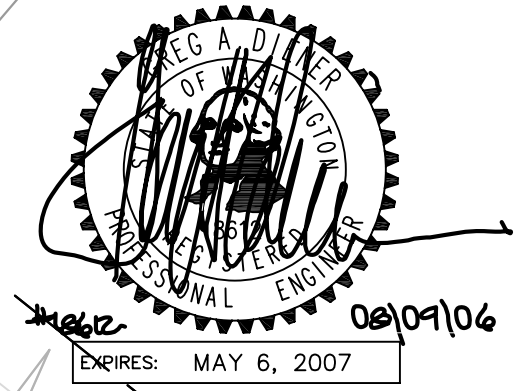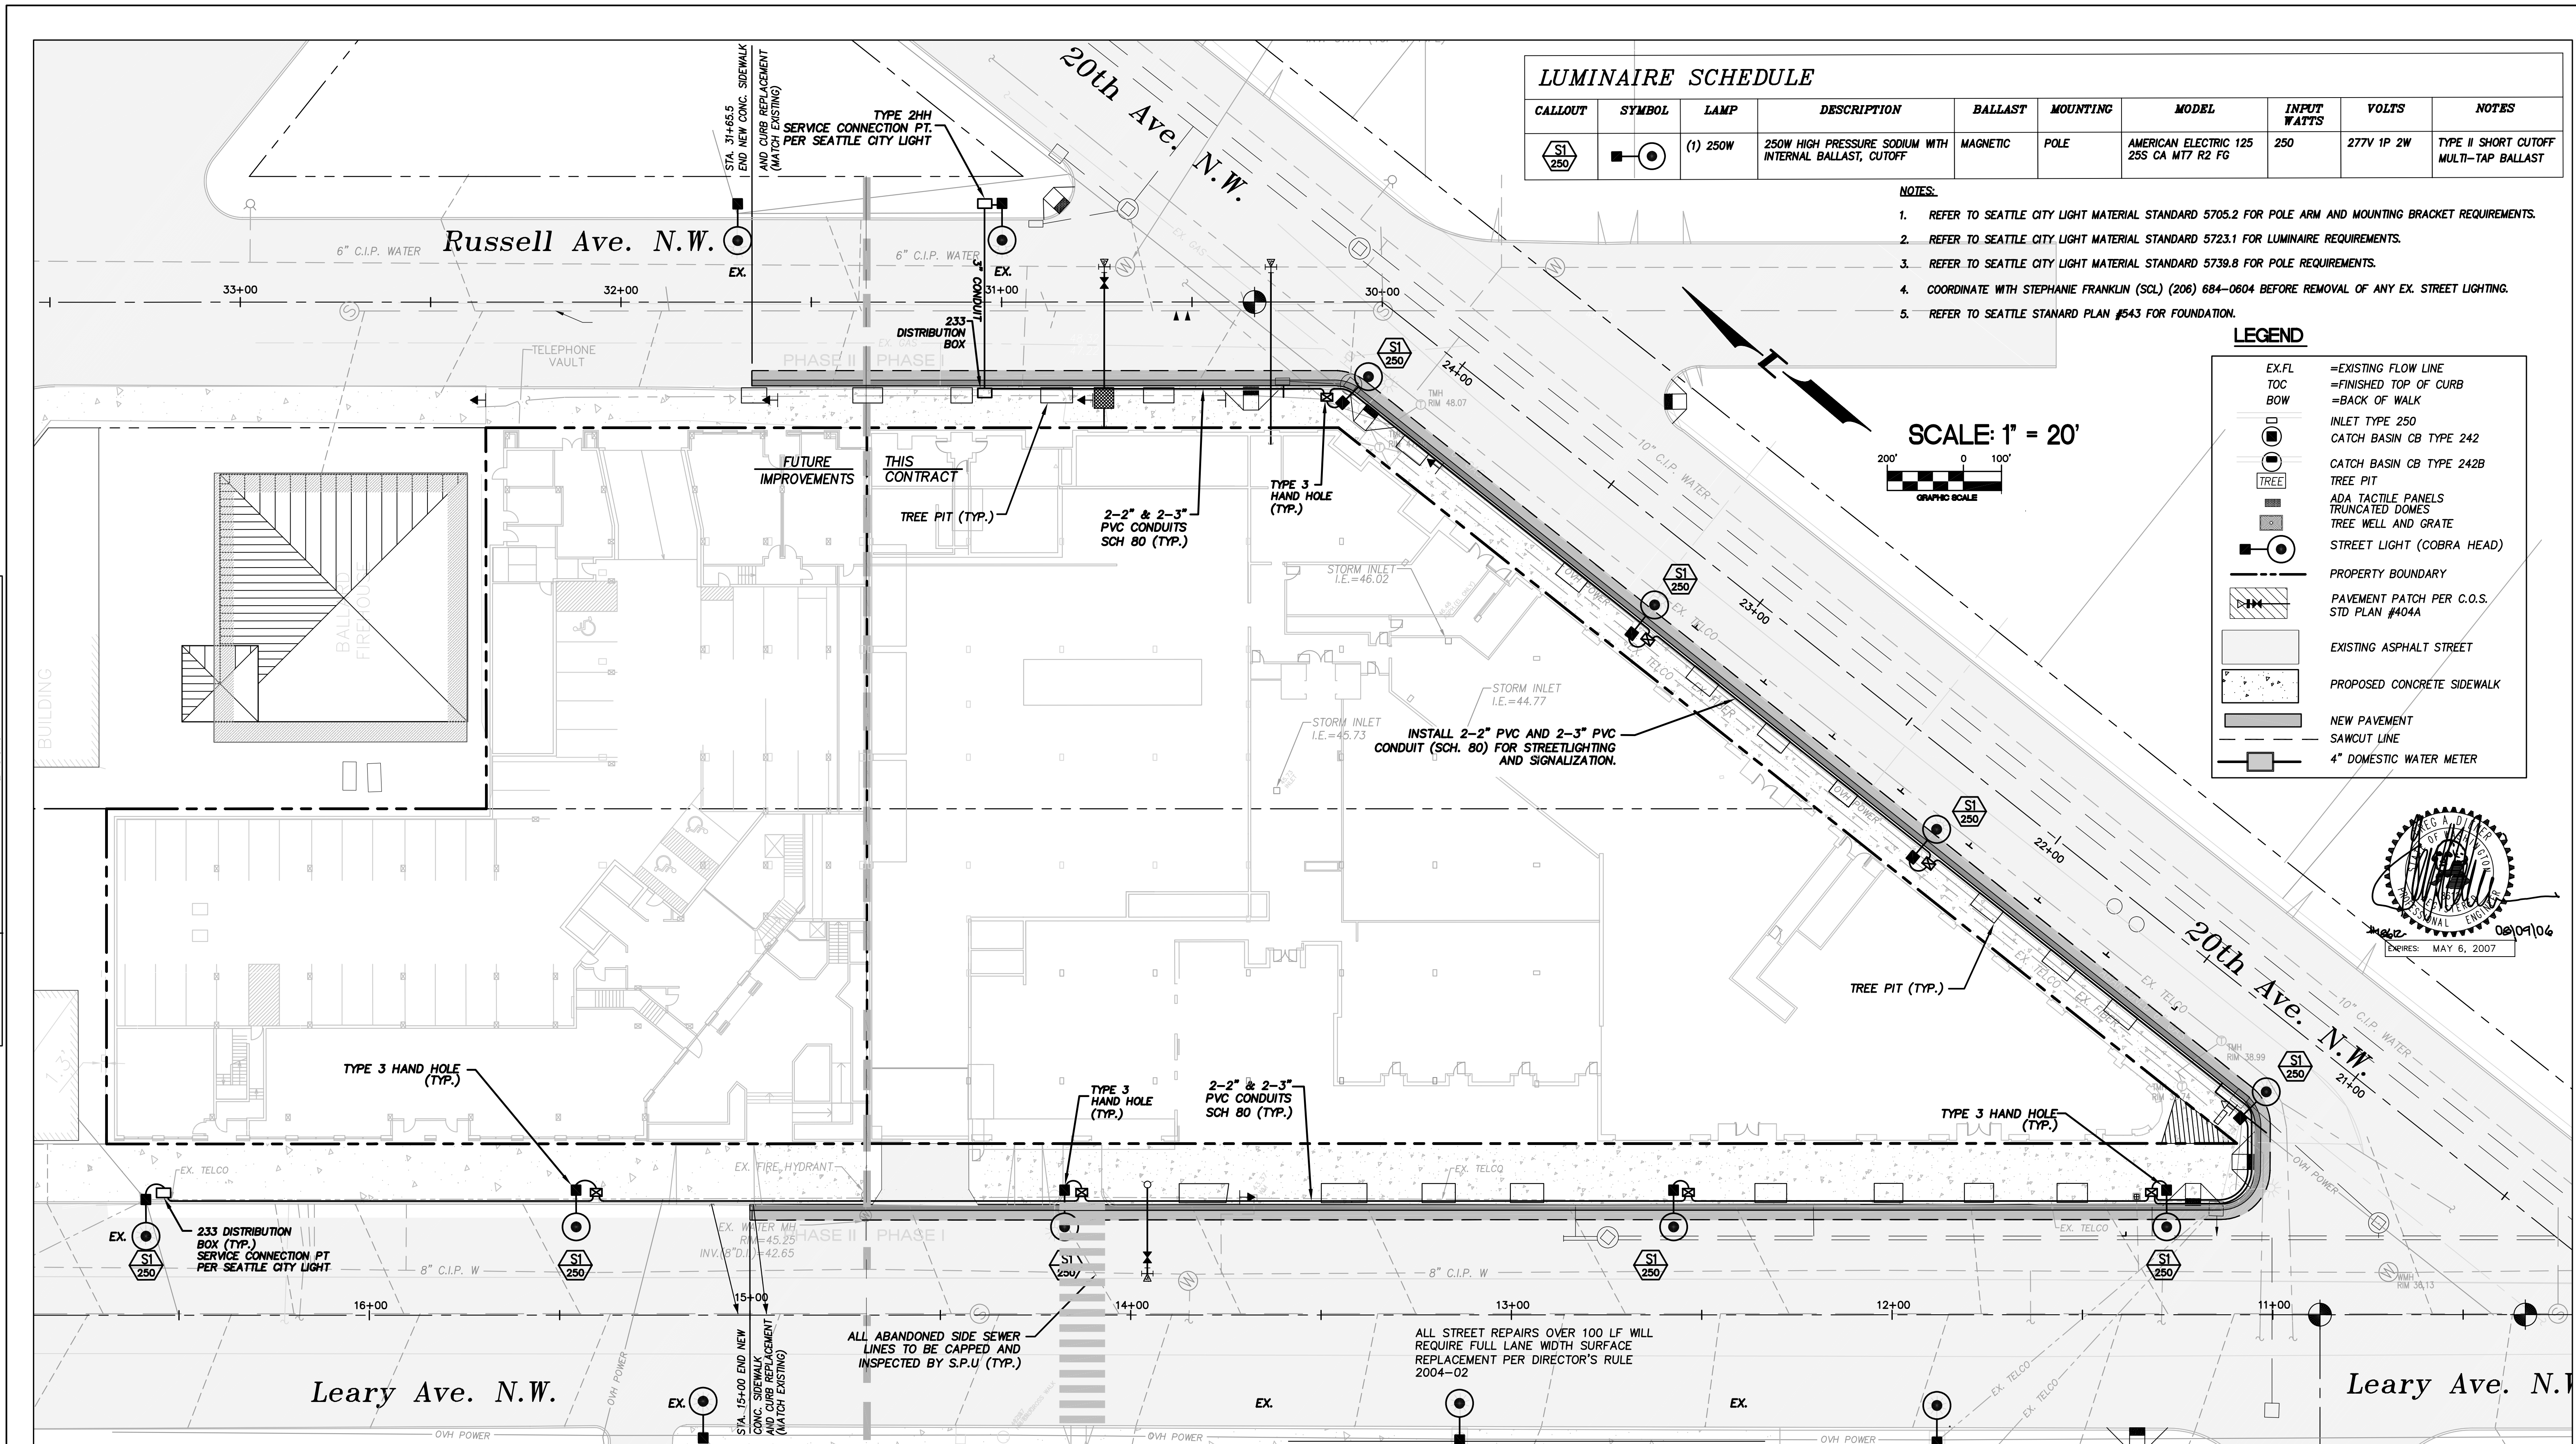

VAULT SERIAL NO.	DATE	MARK	NATURE	REVISIONS	MADE/CHKD	REV'D

**Pacific Engineering Design, LLC**  
 Civil Engineering and Planning Consultants  
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 PHONE: (425) 251-8811 FAX: (425) 251-8880  
 WEB SITE: PACENG.COM

APPROVED BY SEATTLE TRANSPORTATION	20.....
REVIEWED BY SPU/DRAINAGE	20.....
APPROVED BY SDOT STREET IMPROVEMENT PERMITTING	20.....

NAME OR INITIALS AND DATE	INITIALS AND DATE
DESIGNED: L. LARSEN	REVIEWED:
CHECKED: G. DIENER	PLAN REVIEW ANALYST:
DRAWN: D. WHITE	PLAN REVIEW SEC. MGR:
CHECKED: G. DIENER	RECEIVED:
DESIGN REVIEW	REVISED AS-BUILT

All work done in accordance with the City of Seattle Standard Plans and Specifications in effect on the date shown above, and supplemented by Special Provisions.

City of Seattle  
**Seattle Department of Transportation**  
 WORK ORDER NO. TWS7863 SPU W/O# - NS 50118  
 PERMIT NO. 20938 APPROVED  
 SCALE: H:1"=20' V:1"=5' INSPECTOR'S BOOK

Canal Station Condominiums 5440 LEARY AVE. N.W.  
**Leary Ave. N.W.**  
 Street Lighting Plan  
 Street Improvement Plan/Profile  
 SDOT PROJECT NO. 20938  
 VAULT PLAN NO.  
 SHEET 7 OF 8